

BENCH TO BE DUMOR 35 SERIES, 6' WESTERN RED CEDAR WITH S-1 EMBEDMENT 2. ALL COMPONENTS ARE MADE OF ALL STEEL MEMBERS COATED W/ ZINC RICH EPOXY THEN FINISHED W/ POLYESTER POWDER COATING OR APPROVED EQUAL

LOCAL REPRESENTATIVE ARBOR ASSOCIATES, INC P.O. BOX 650698 STERLING, VA 20165 703-437-7333 Toll Free: 800-926-1596 Fax: 703-437-0743 E-Mail: greg@arborrec.com

MANUFACTURERS TO BE: DuMor, inc. P.O. Box 142 Mifflintown, PA 17059

PHONE: 717-436-2106 FAX: 02-005A

NTS

03-001J

1" = 1'-0"


717-436-9839


TACK COAT -3/4" BITUMINOUS SETTING BED BRICK PAVEMENT SECTION CUTBACK ASPHALT PRIMER -CONCRETE OR ASPHALT BASE STONE SUBBASE (AASHTO MA3, NO.57) -COMPACTED SUBGRADE

- BRICK PAVERS

ANNAPOLIS BRICK PAVER CROSSWALK (R 2.1)

03-020B 1" = 1'-0"

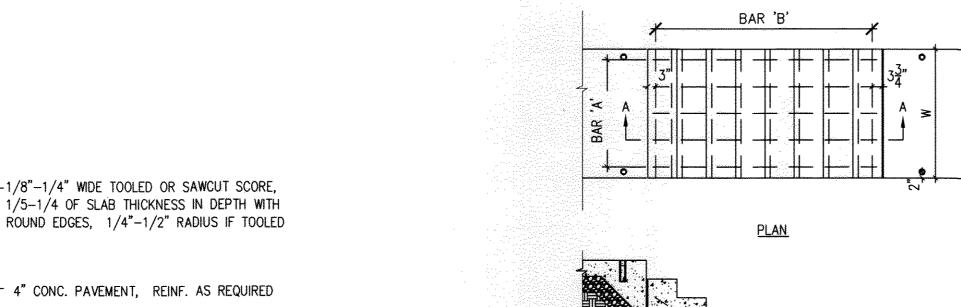

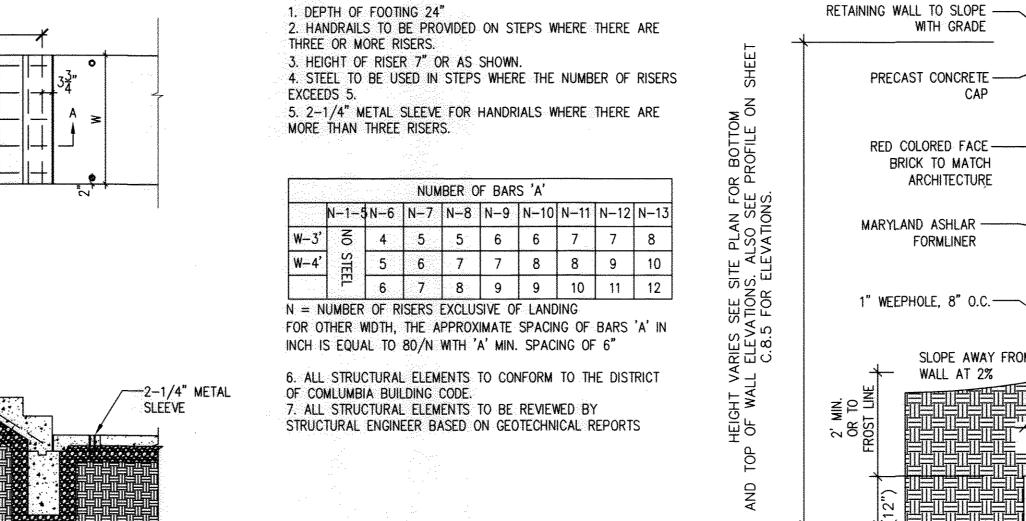

CANTILEVER RETAINING WALL 06-004A L.3.0 / SECTION 1/3" = 1' - 0"

03 - 003MAS SHOWN -LIMITS OF CLEARING & GRADING 1. RETAINING WALL TO STEP WITH GRADE. SEE SITE GRADING PLAN FOR TOP OF WALL ELEVATIONS. 2. DESIGN IS SCHEMATIC ONLY AND IS SUBJECT TO REVIEW ALLEN BOL PLANNED I AND MODIFICATION AS NECESSARY BASED ON SITE SPECIFIC GEO-TECHNICAL DATA PRIOR TO APPROVAL BY STRUCTURAL ENGINEER.

> RETAINING WALL TO BE DESIGNED BY OTHERS!

05-0032A 1/2" = 1'-0"


CONCRETE STAIR REINFORCEMENT (L.3.0) Plan and Section

BAR 'A' (#4 SIZE)

SECTION 'A-A'

1. ALL STRUCTURAL ELEMENTS TO CONFORM WITH DISTRICT OF COLUMBIA BUILDING CODE. 2. ALL STRUCTURAL ELEMENTS TO BE REVIEWED BY STUCTURAL ENGINEER BASED ON GEOTECHNICAL REPORTS 3. ALL FIELD WELDING SHALL BE GROUND SMOOTH AND CLEANED PRIOR TO PAINTING. 4. INTERMEDIATE POSTS FOR HANDRAIL SHALL BE PROVIDED PER CHART.

1 RISER	NO HANDRAIL	
2 RISERS	NO HANDRAIL	
3 RISERS	NO INTERMEDIATE	
4 RISERS	NO INTERMEDIATE	
5 RISERS	ON 3RD RISER	
6 RISERS	ON 3RD RISER	
7 RISERS	ON 2ND AND 5TH RISER	
8 RISERS	ON 2ND AND 5TH RISER	

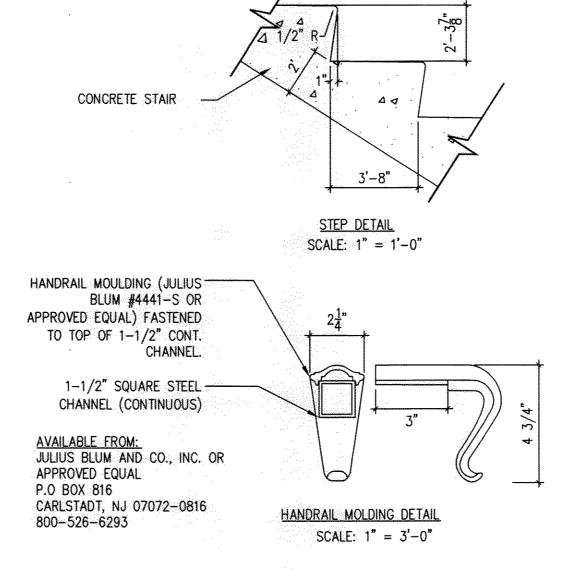

— 2 ½" POST (3) 1 1/6" X 1 1/4" FORE RUNNER RAIL ¾" PICKET

PERMALOC CORPORATION, 13505 BARRY STREET HOLLAND, MI, 49424

SIZE AND FINISH:

GUIDELINES"

(800) 356-9660,

(616) 399-9600

CONTRACTOR'S NOTE

PURCHASING INFORMATION

VISIT: WWW.PERMALOC.COM

1. OR APPROVED EQUAL

FOR PRODUCT AND

%6" X 2¼" (4.8MM X 57MM) w/ 0.210" (5.33MM) TOP LIP

(MF) MILL FINISH-NATURAL ALUMINUM

INSTALL PER MANUFACTURER'S "INSTALLATION

CONNECTION BETWEEN SECTIONS TO UTILIZE

PERMALOC CORPORATION, HOLLAND MI.

MANUFACTURERS' SLIDING CONNECTOR SYSTEM.

PERMALOC STRUCTUREDGE AS MANUFACTURED BY

/ AXONOMETRIC/SECTION

ORNAMENTAL FENCE/GUARDRAIL

CORNERS: NOTCH BASE ONLY AND FORM A CONTINUOUS

ALUMINUM PAVING EDGE OVER AGGREGATE BASE

(800) 356-9660 PHONE: (616) 399-9600 fax: (616) 399-9770 WWW.PERMALOC.COM

SPECIFIED VEGETATION -

PERMALOC STRUCTUREDGE -

4" CRUSHED AGGREGATE-

%" X 12" STEEL SPIKE 2' O.C

EXISTING SOIL OR AMENDED SOIL-

XNEAREST STORM ≪DRAIN SYSTEM

AS REQ.

- 6"PREPARED SUBGRADE

(COMPACTED STONE)

2 1 RED BRICK PAVER -

SUB-BASE

GRASS

SWALE

ALUMINUM PAVER RESTRAINT

5' ALLUMINUM ORNAMENTAL FENCE

MANUFACTURER TO BE: AMERISTAR 1555 N. MINGO TULSA, OK 74116 1-800-321-8724

DISTRIBUTED BY: ATLANTIC FENCE & SUPPLY CO. 6875 WASHINGTON BLVD. ELKRIDGE, MD 21075 TEL: 410-796-4747

1. ECHELON PLUS - GENESIS 5' HIGH 3-RAIL X 8' (NOMINAL) PANEL 2. COLOR TO BE BLACK 3. NUTS TO BE TAMPER PROOF 4. 5 YEAR MAINTENANCE FREE WARRANTY PROVIDED 5. ALL GATE LATCHES TO BE SELF LATCHING. 6. INSTALL PER MANUFACTURER'S

INSTRUCTIONS 7. OR EQUAL

8. DESIGN IS SCHEMATIC ONLY. ALL STRUCTURAL ITEMS TO BE REVIEWED BY STRUACTURAL ENGINEER.

01 - 015A

1 1 1 1 1 1 1 1 1 1 1 1 1 1 1 1 1 1 1		 — 4' CONCRETE STOOP — HANDRAIL TO BE LOCATED ON BOTH SIDE OF STAIR WHERE REQUIRED — TOP RISER (CONCRETE STOOP) TO BE VERTICAL — HEIGHT OF TOP OF HANDRAIL TO BE MAX. 38" AND MIN. 34', TOP RAIL 2 1/4" WIDE
	$1 - 6\frac{11}{16}$ $2\frac{1}{4}$	
SCALE: 1/2" = 1'-0"		— 4" AGGREGATE BASE — 1/2" EXPANSION JOINT TYPICAL — CONCRETE FOOTING REINFORCED AS REQUIRED — PREPARED SUBGRADE

— 4" AGGREGATE BASE

PREPARED SUBGRADE

CONCRETE STOOP, STAIRS, AND HANDRAIL

CONCRETE PAVING CONTROL JOINT

THESE PLANS ARE BASED UPON PLANS TITLED 'ARIS ALLEN BOULEVARD, LLC MIXED

RESIDENTIAL' CREATED BY BOWMAN CONSULTING, PORTIONS OF WHICH ARE USED HEREIN.

06-003A SCALE AS SHOWN

/ ELEVATION

ORNAMENTAL FENCE PANEL

1/2" = 1'-0"

COPYRIGHT © 2014, McLAREN ENGINEERING GROUP

PROJECT NO. 130003.0 AS SHOWN 5/30/2014 JDS/CLW PVM/TJC

STOP MARY D

No. 21875

SE DOCUMENTS WERE PREPARED OR APPROVE E, AND THAT I AM A DULY LICENSED PROFESSIONA

Expiration Date: 2/1

GINEER UNDER THE LAWS OF THE STATE OF

ense No.: 21875

SHEET TITLE